3.2 The Fountains: Landmarks of Market Square Through Time

The Hobson's Conduit was also known as Hobson's River and Cambridge New River. In the 16th and 17th Centuries increasing numbers of students and university staff were dying of plague due to the city's uncleanliness. The Master of Peterhouse, Andrew Perne, first suggested in 1574 the idea of taking fresh water from Nine Wells to clean out the King's Ditch on the southern and eastern edges of town. In early 1600 Hobson donated money for a conduit to bring fresh water from Trumpington to a fountain built to provide clean drinking water for the people of Cambridge. A subsequent four-year building project was undertaken in 1610, with a small artificial river being constructed which flowed along both sides of Trumpington Street towards St Catherine's College.

The Market Place branch of Hobson's Conduit was completed in 1614 and brought fresh water to a central fountain. This fountain was made of stone incorporating decorative carvings and provided access to fresh water for residents and traders. As such the fountain became a gathering point for the community as a central point for the city. This original fountain, Hobson's Conduit, was removed from Market Hill to its present site at the junction of Trumpington Road and Lensfield Road. This was due to Market Square being redeveloped in 1855 following the Great Fire and a Gothic Revival gabled fountain being erected in its stead. The fountain's original stone canopy was removed in 1953 having been found to be unsafe.

With the emergence of the private motorcar at the turn of the 20th century the market space began its evolution towards the configuration we see today. The Gothic Revival fountain was erected in 1953 which maintained the flow of fresh water to the square, however the conduit which supplied the fountain was cut off in the 1960s during the construction of the Lion Yard shopping centre development.



From 1614 - 1856

The Market Place branch of Hobson's Conduit was completed in 1614. This branch brought fresh water to the market fountain in the centre of the previous Market Place



From 1855 - 1953

Following the fire in 1849, the Market Square was redeveloped. In 1855 a Gothic Revival gabled fountain was erected and the original structure of Hobson's Conduit was moved to the corner of Lensfield Road and Trumpington Road in south Cambridge in 1856.




From 1953 - present

In 1953 the fountain was found to be unsafe and taken down. It was removed to the yard of the Cambridge and County Folk Museum, which is the former site of the old White Horse Inn in Castle Street.



Engraving of Thomas Hobson

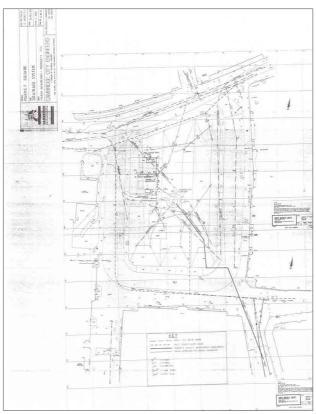

Drainage system - Hobson's Conduit abandoned Cambridge City Engineer surveyed in 1992



Hobson's Conduit

3.2 The Fountains: Grade II Listed Central Fountain Feasibility



Cambridge Preservation Societyrestoration design- 1995

PROPOSED ELEVATION



From 1614 - 1856 1995 Rebuild Cost-£55,000.00-£90,000.00



From 1855 - 1953 1995 Rebuild Cost-£175,000.00



From 1953 - present 1995 Rebuild Cost- £85,000.00 - £110,000.00

THE MARKET SQUARE, CAMBRIDGE - CONDUIT BUDGET ESTIMATES FOR THE VARIOUS OPTIONS CONTAINED IN THE FEASIBILITY STUDY

		£
1.	Hobsons conduit returned to the Market Square including new base.	65,000
2.	Hobsons conduit replica (without crestings).	90,000
3.	Hobsons conduit - simplified design.	55,000
4.	Gothic fountain rebuilt on existing base.	175,000
5.	Gothic fountain - simplified design.	110,000
6.	Cambridge Preservation Societies design.	85,000
	Rattee and Kett further options -	
7.	Cambridge composition by Matthew Simmonds.	75,000
8.	Lead cupola Trinity type fountain.	65,000
9.	Obelisk or column.	65,000
10.	Standard cast iron products.	70,000
11.	Standard cast stone mouldings.	45,000

The budgets exclude VAT and have been formulated on current day costs excluding any professional or statutory fees or contingencies.


Budget costs for the restoration of the central fountain in 1995. Figures shown are taken from report 'The Market Square, Cambridge Fountain and Conduit Feasibility Study' by Rattee And Kett 1995

Market traders tollet facilities (position diagramatic only)


NOTES

Contractor to verify all dimensions/levels on site prior to construction.

2)Do not scale this drawing

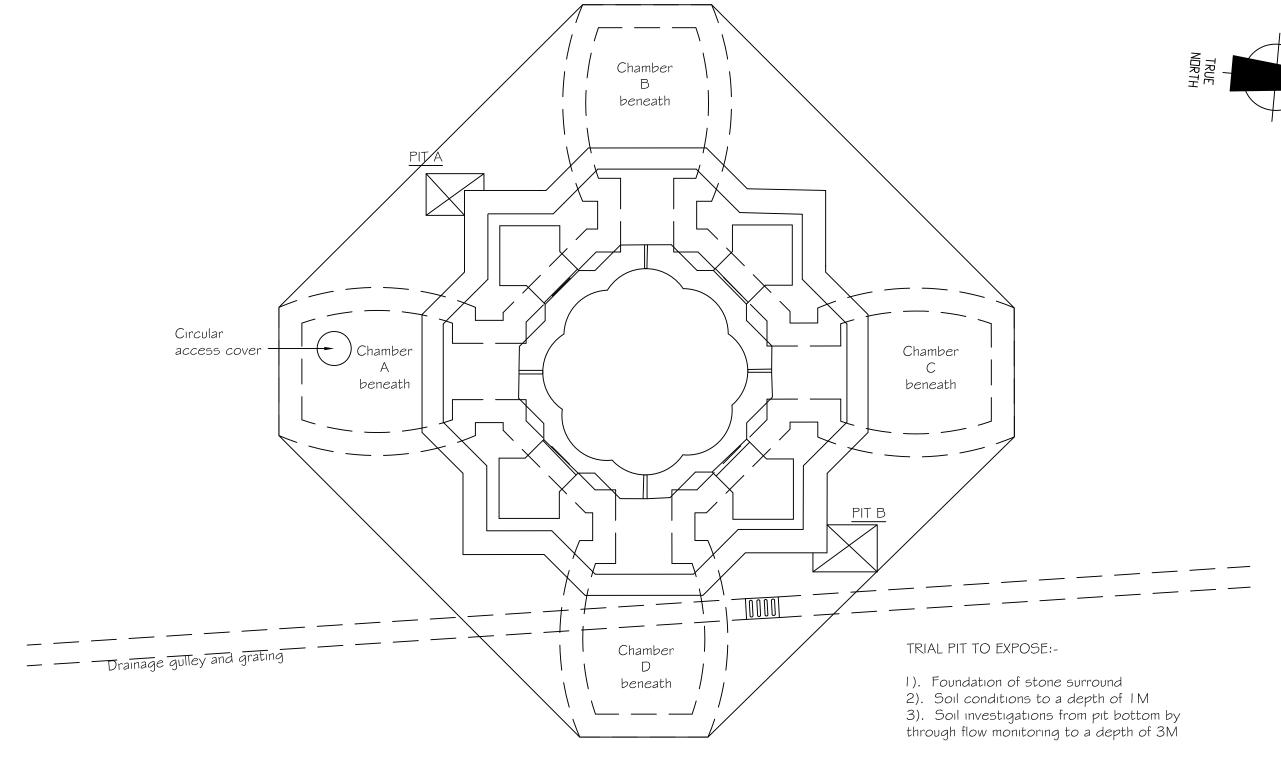

A Requirements revised A	AC.	-	15/08/01

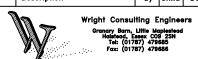

Client Cambridge City Council, Environment and Planning

Project Cambridge Market Square Fountain

Drawing Title

Trial Pit Location and Requirements

Drawn AC	Checked _	Approved	
Scale 1:50	Drawing No		Rev.
Date 3/08/01	1274/		Α

























NOTES

Contractor to verify all dimensions/levels on site prior to construction.

2)Do not scale this drawing





Wright Consulting Engineel
Granary Barn, Little Maplestead
Haistead, Essex CO9 2SN
Tel: (0.1787) 479685
Fax: (0.1787) 479686

Client

CAMBRIDGE CITY COUNCIL


Project MARKET SQUARE FOUNTAIN


Drawing Title


STONEWORK LEVELS

Drawn L.P	Checked _	Approved	
Scale NTS	Drawing No	,	Rev.
Date 26/11/01	1274/05)	1

East Elevation – Left Side 2002

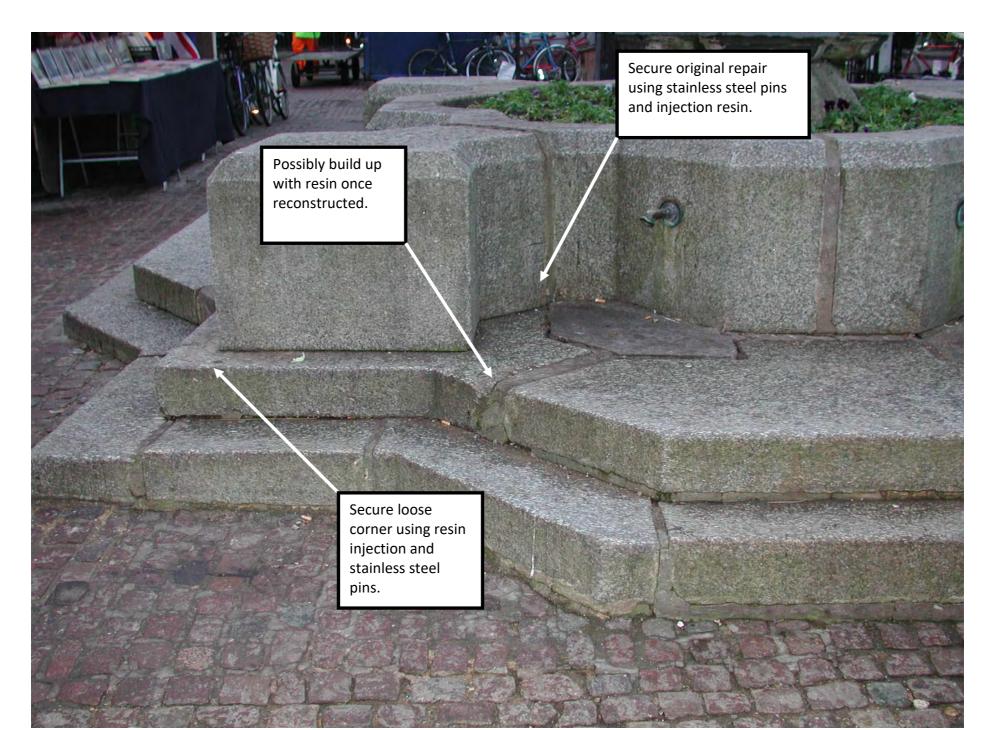

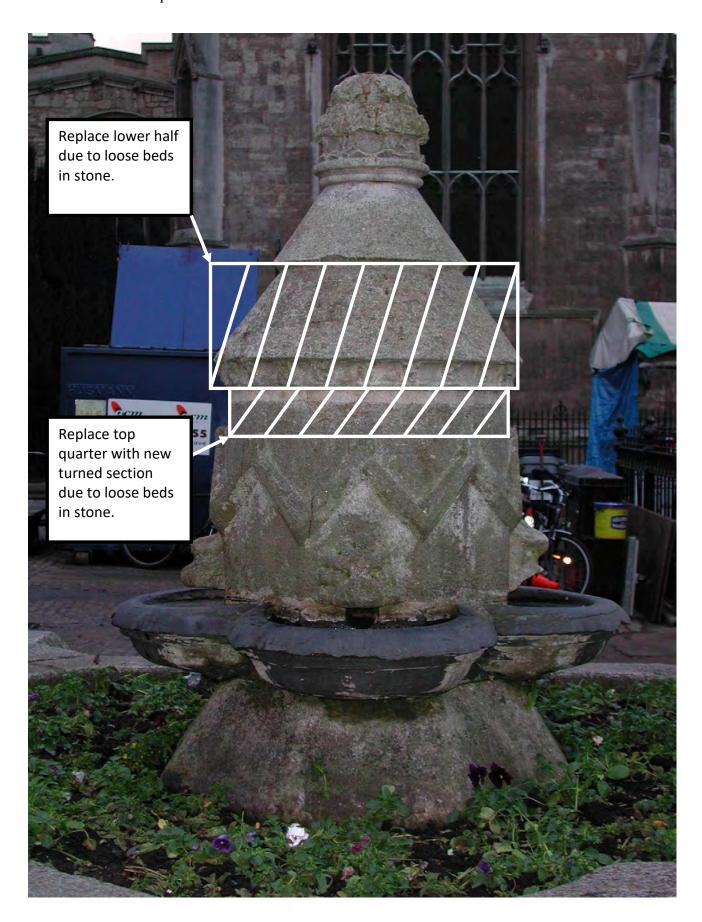

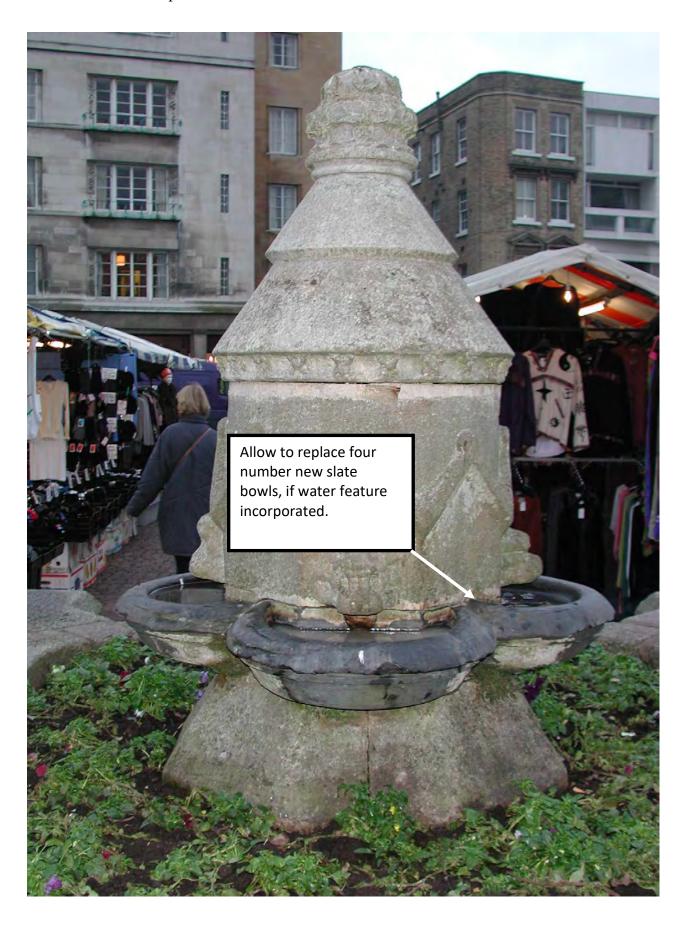







Fountain Repair Considerations (not exhaustive):

- 1. Historical development understand, maintain and repair
- 2. Fountain Repair Progressive foundation movement, creation of undersurface voids, iron cramp corrosion, vandalism
- 3. Fountain Use Load carrying capacity of underground vaults, water supply and drainage, protection etc
- 4. Statutory Services Access, maintenance, repair and alteration
- 5. Archaeology unlikely but possible ref. trench 2001
- 6. Surface Water Drainage additional capacity if water reinstated
- 7. Respecting the past and repairing for the future servicing, security, structural & service capacity and environmental health